*PLEASE READ FIRST:

- 1) THIS LINEAR LIGHTING SYSTEM SHOULD BE INSTALLED PRIOR TO THE INSTALLATION OF THE CEILING.
- 2) ALL REFERENCES TO LEFT AND RIGHT HAND SIDE INSTALLATION ARE BASED ON VIEWING THE SYSTEM FACING THE WALL WITH THE FIXTURES IN THE INSTALLED POSITION.
- 3) ALL FIXTURE RUNS ARE CONSTRUCTED LEFT TO RIGHT.
- 4) LETTERS REFER TO INSTALLATION STEPS BELOW. NUMBERS REFER TO PARTS LISTING.

*INSTALLATION PROCEDURE


A STEP A - MOUNT WALL SIDE EXTRUSIONS.

Using #8 screws install WALL EXTRUSION 1 with bottom face flush with finished ceiling line.

Shim as required to maintain flat and straight installation. Maintain within ± 3 mm $\left[\pm 1/8\right]$ at all times.

B STEP B - INSTALL END UNITS.

Measure wall and fixture run length and position starter fixture to center run on wall. Install Starter Fixture at Left and suspend. Mount End Extension/Cover over body of fixture. (See Fig. A and Fig. B)

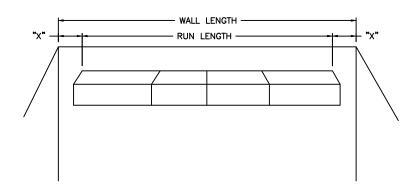

C STEP C - INSTALL REMAINING FIXTURES AS REQUIRED TO COMPLETE THE RUN.

The length of the FIXTURE RUN determines the type of units used at the beginning and for subsequent fixtures.

All fixture housings should be screwed together at each joint See (FIG. D).

Caution should be taken to ensure that wires are not pinched during this operation.

Applications involving emergency circuits require the use of fixtures with EMERGENCY designation.

PROGRESSIVELY CONNECT MAIN POWER SUPPLY

D STEP D - MOUNT CORNER UNITS OVER FIXTURES AT CORNER AND SECURE WITH SCREWS TO EXTRUSIONS.

E step e - secure lamp fixture assemblies to wall extrusions

F STEP F - SECURE LAMP FIXTURE ASSEMBLIES TO CEILING EXTRUSIONS
Install spacer brackets (SHIPPED SEAPATELY) to maintain
opening during the balance of the installation procedure.
(see FIG. C)
THE OPENING MUST BE HELD WITHIN 3mm [1/8"]

G STEP G - TRIM AND INSTALL CEILING TILE.


H STEP H - REMOVE SPACER BRACKETS.


K STEP K - INSTALL LAMPS, LOUVRES or BAFFLES.


CAUTION

CAUTION SHOULD BE TAKEN WHEN CONNECTING THE POWER SUPPLY AND ENERGIZING THIS SYSTEM. THIS LINEAR RECESSED LIGHTING SYSTEM IS A CONTINUOUS MULTIPLE CIRCUIT LIGHTING ASSEMBLY THAT CAN BE ENERGIZED FROM SEVERAL POINTS. ALL ELECTRICAL CIRCUITS SHOULD BE CONNECTED ACCORDING TO THE ELECTRICAL PLANS.

MATERIAL	BY MK	TITLE INSTALLATION IN	STRUCTION -CS1-		
FINISH	CHK'D	PERIMETER			
DATE 05/07/12	SCALE NTS		IS-CS1-01		

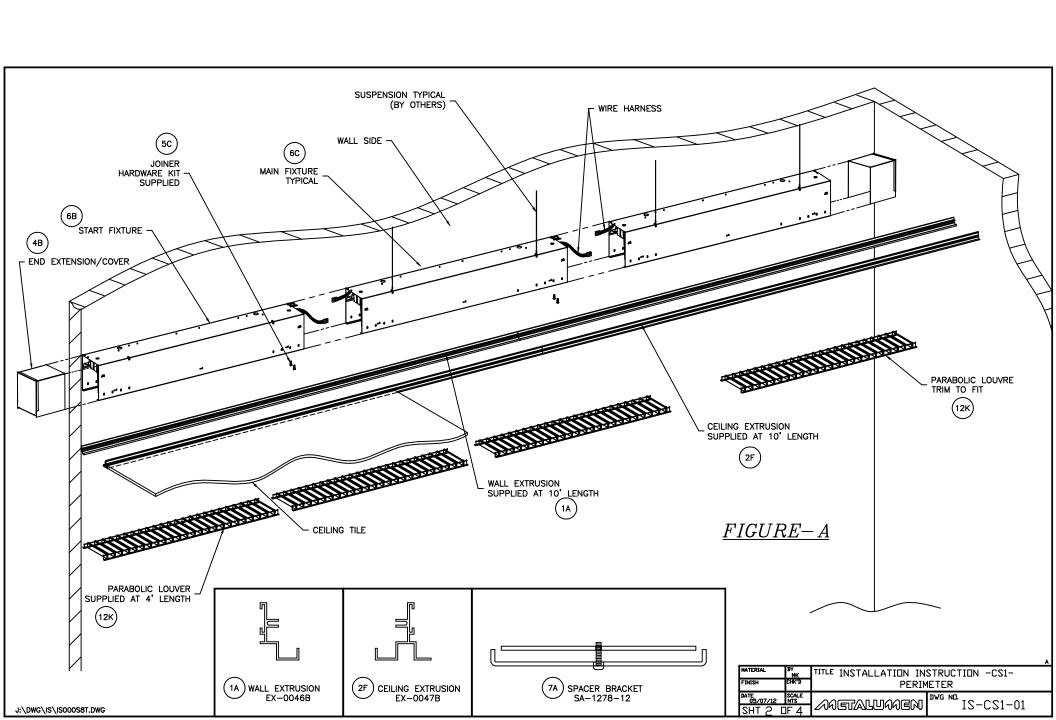


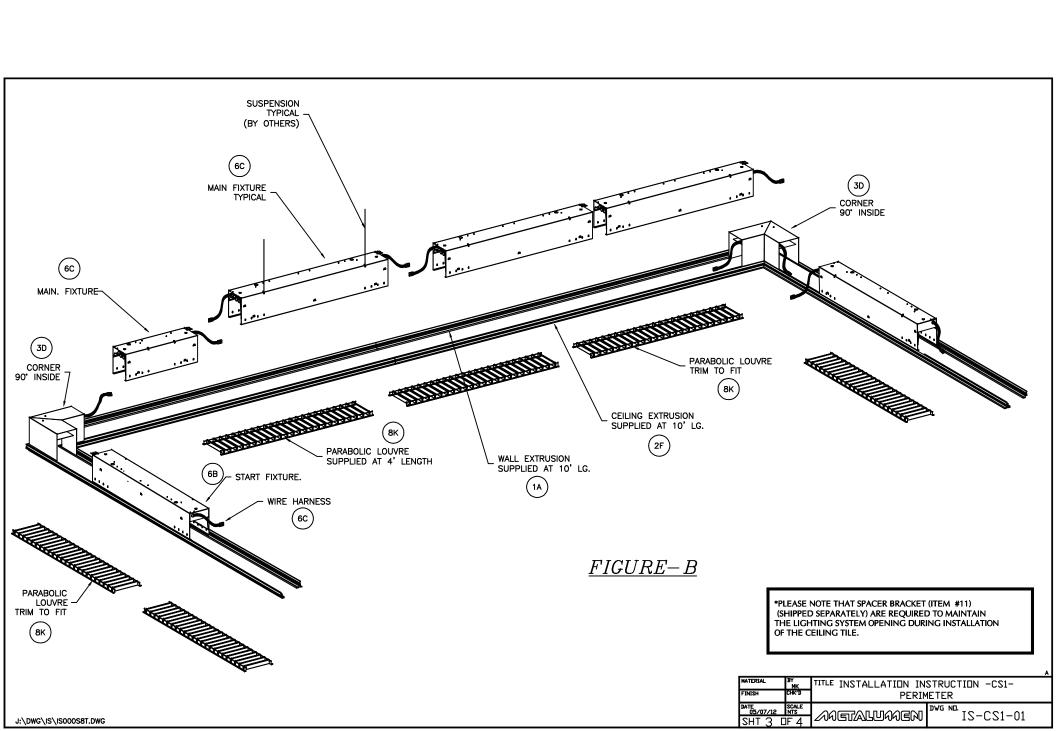


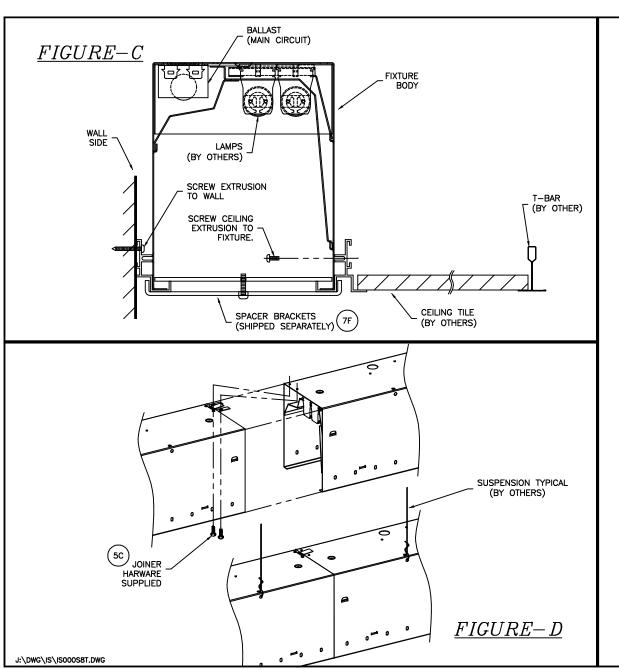

*PARTS LIST/DESCRIPTION

- 1- WALL SIDE EXTRUSION EX-0046B WALL SIDE EXTRUSION
- 2- CEILING SIDE EXTRUSION EX-0047B CEILING SIDE EXTRUSION
- 3- CORNERS
 CS1-C90 INSIDE/OUTSIDE 90° CORNER
 CS1-C45 INSIDE/OUTSIDE 45° CORNER
- 4- END EXTENSION/COVER CS1-EC-01
- 5- HARWARE KIT CS1-HDWR -> # 8x5/16" LG. SHEET METAL SCREWS.
- 6- MAIN FIXTURE CS1-1XT8(T5)-2/3/4/8-START 1 LAMP FIXTURE 2'/3'/4'/8' START/MID/END/ALONE FIXTURE. CS1-2XT8(T5)-2/3/4/8-START 2 LAMP FIXTURE 2'/3'/4'/8' START/MID/END/ALONE FIXTURE.
- 7- SPACER BRACKETS SA-1278-12 SPACER BRACKETS (SHIP SEPARATELY)
- 8- PARABOLIC LOUVRE SA-4343-148 48" PARABOLIC LOUVRE (SHIP SEPARATELY)

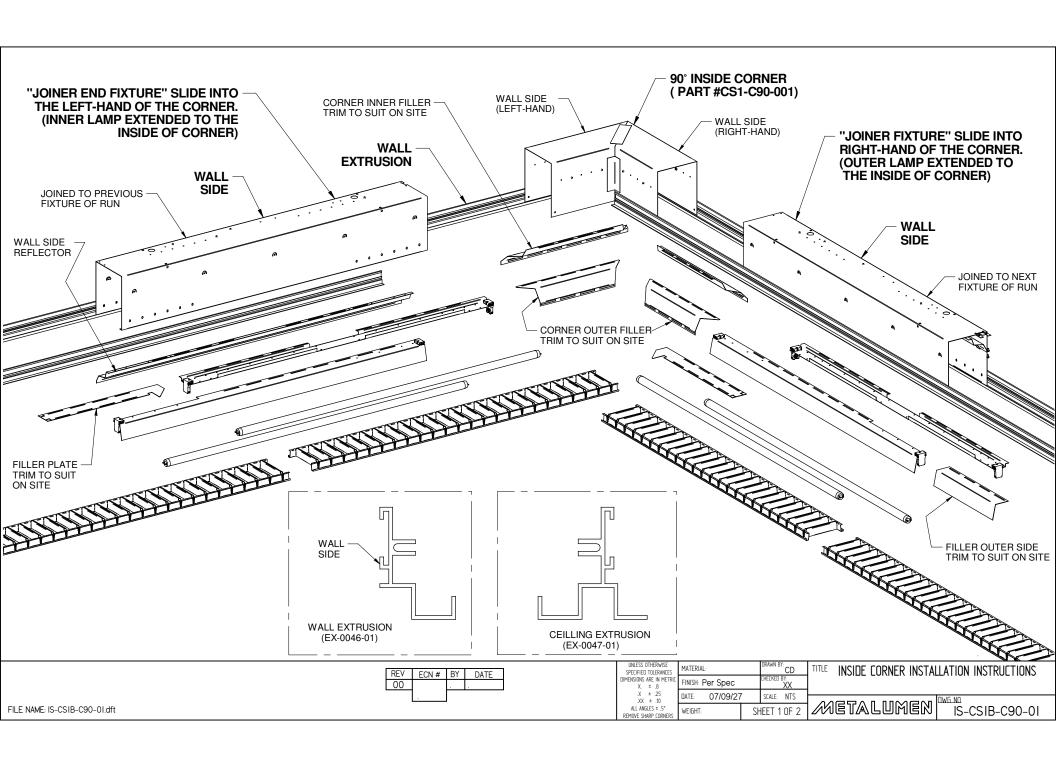

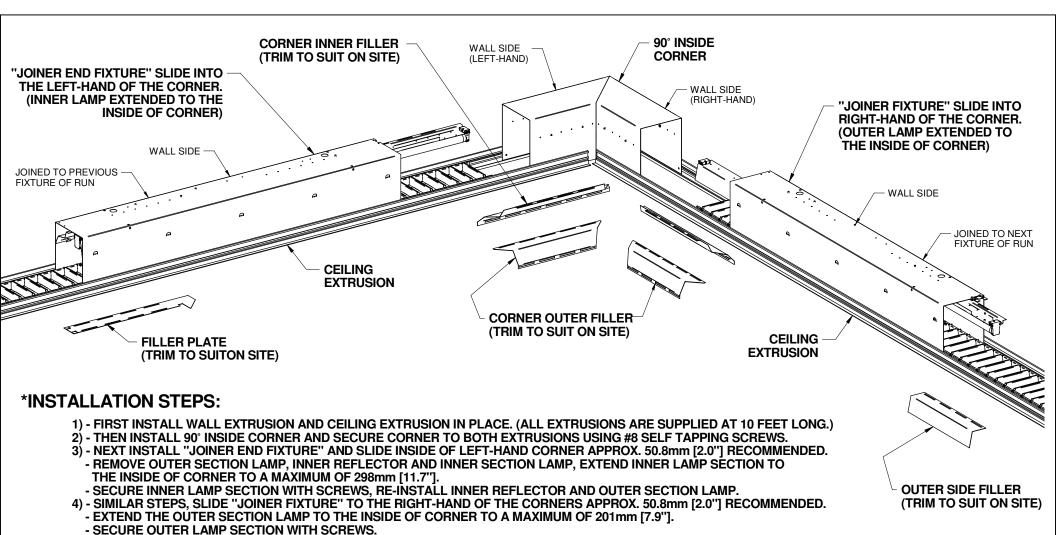

- 5) TRIM TO SUIT AND INSTALL CORNER INNER AND OUTER FILLERS.
- 6) TRIM TO SUIT AND INSTALL FILLER PLATES.
- 7) TRIM TO SUIT AND INSTALL OUTER SIDE FILLER.
- 8) INSTALL PARABOLIC LOUVERS (OPTION) AND TRIM TO SUIT. (*NOTE: ALL PARABOLIC LOUVERS ARE PROVIDED AT 4 FEET LONG.)

				•
	REV ECN # RY DATE	UNLESS OTHERWISE SPECIFIED TOLERANCES MATERIAL:	DRAWN BY: CD	TITLE INSIDE CORNER INSTALLATION INSTRUCTIONS
	00	DIMENSIONS ARE IN METRIC FINISH: Per Spec	CHECKED BY:	
		X ± 25 XX ± 10 DATE: 07/09/27	7 SEALE: NTS	
FILE NAME: IS-CSIB-C90-01.dft		ALL ANGLES ± .5° REMOVE SHARP CORNERS WEIGHT:	SHEET 2 OF 2	ØETALUMEN IS-CSIB-C90-01

